
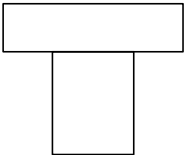
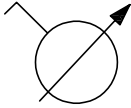
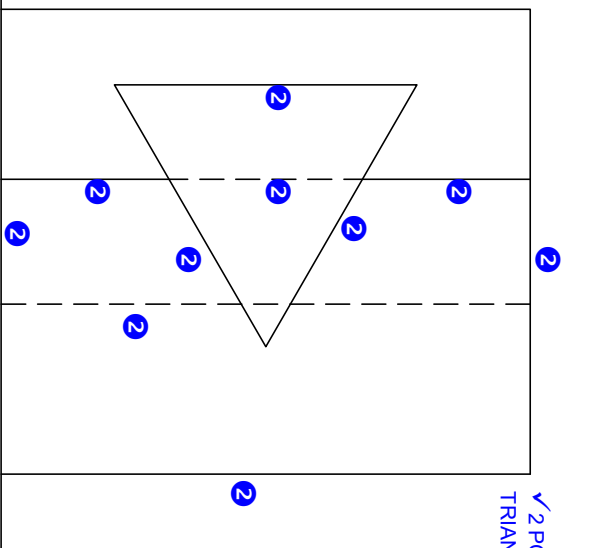



ANSWERS			
1	DRAWING NUMBER	1	
2	MR D BRITS	1	
3	CHEETAH PRINTERS	1	
4	POLOKWANE	1	
5	ADD WATER TANK	1	
6	1173,5 m	1	
7	BUILDING LINE	1	
8	WILLOW TREE	1	
9	2000	1	
10	EXISTING FENCE TO BE REMOVED	1	
11	WATER STORAGE TANK	1	
12	PAVERS	1	
13	BUILT IN CUPBOARD	1	
14	BROWN	1	
15	$4,5 + 4,5 + 4,58 + 3 = 16,58\text{m}$	2	
16	NORTH EAST	2	
17	22	2	
TOTAL		30	

ANSWER 18 Show ALL calculations	ANSWER 19 Show ALL calculations
$\begin{aligned} \text{PERIMETER} &= 76,77 + 63,34 + 76,77 \\ &+ 63,34 \\ &= \underline{\underline{280,22 \text{ m}}} \end{aligned}$	$\begin{aligned} \text{AREA} &= (7,7 \times 1,5) + (9,6 \times 17,5) \\ &+ (3,5 \times 10,7) + \left(\frac{1}{2} \times 10,7 \times 2,4\right) \\ &= 11,55 + 168 + 37,45 + 12,84 \\ &= \underline{\underline{229,84 \text{ m}^2}} \end{aligned}$
ANSWER 20	
	

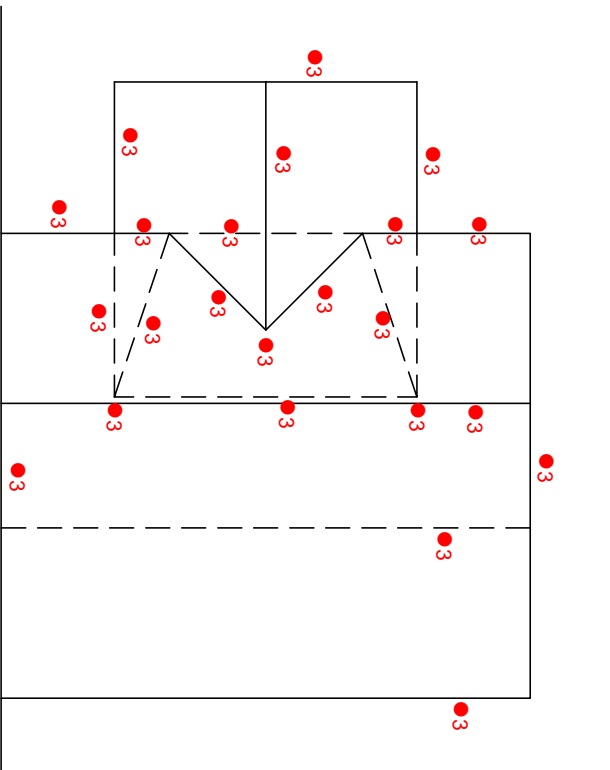


✓ 2 POSITION OF TRIANGLE




ASSESSMENT CRITERIA		
1	TOP VIEW	4
2	LEFT VIEW	6 $\frac{1}{2}$
3	FRONT VIEW	11 $\frac{1}{2}$
4	DEVELOPMENT	7
TOTAL		29

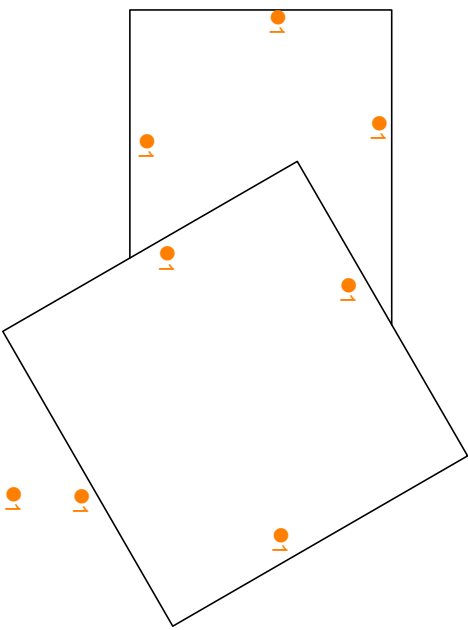


✓ 1 ANGLE

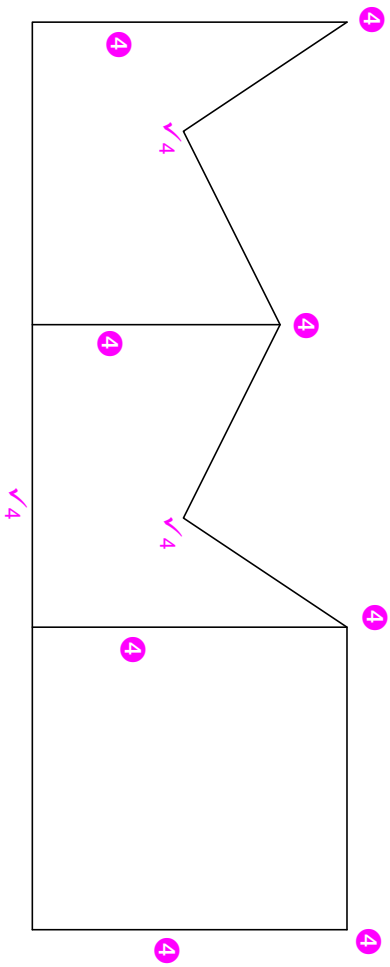


ASSESSMENT CRITERIA		
1	CONSTRUCTION + VPS	6
2	STEPS	9 $\frac{1}{2}$
3	WALLS	11
4	OPENINGS	4
5	ROOF	5 $\frac{1}{2}$
TOTAL		36

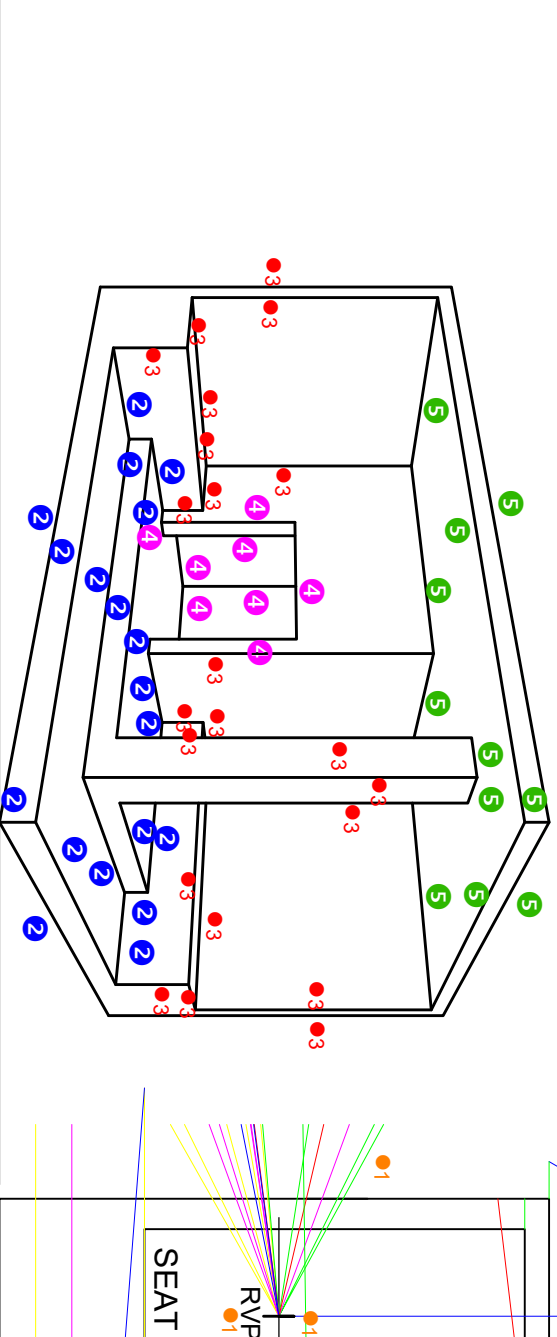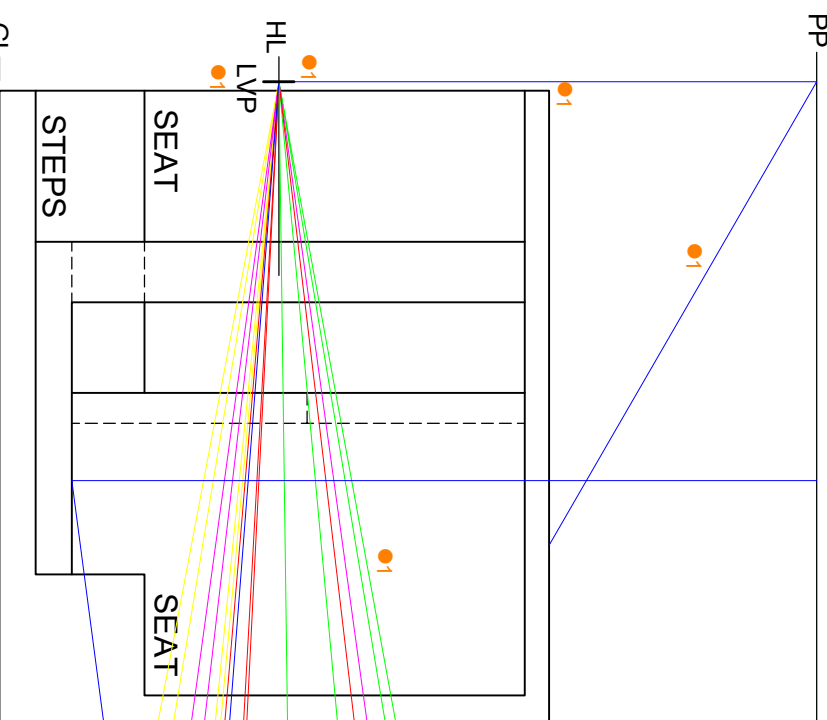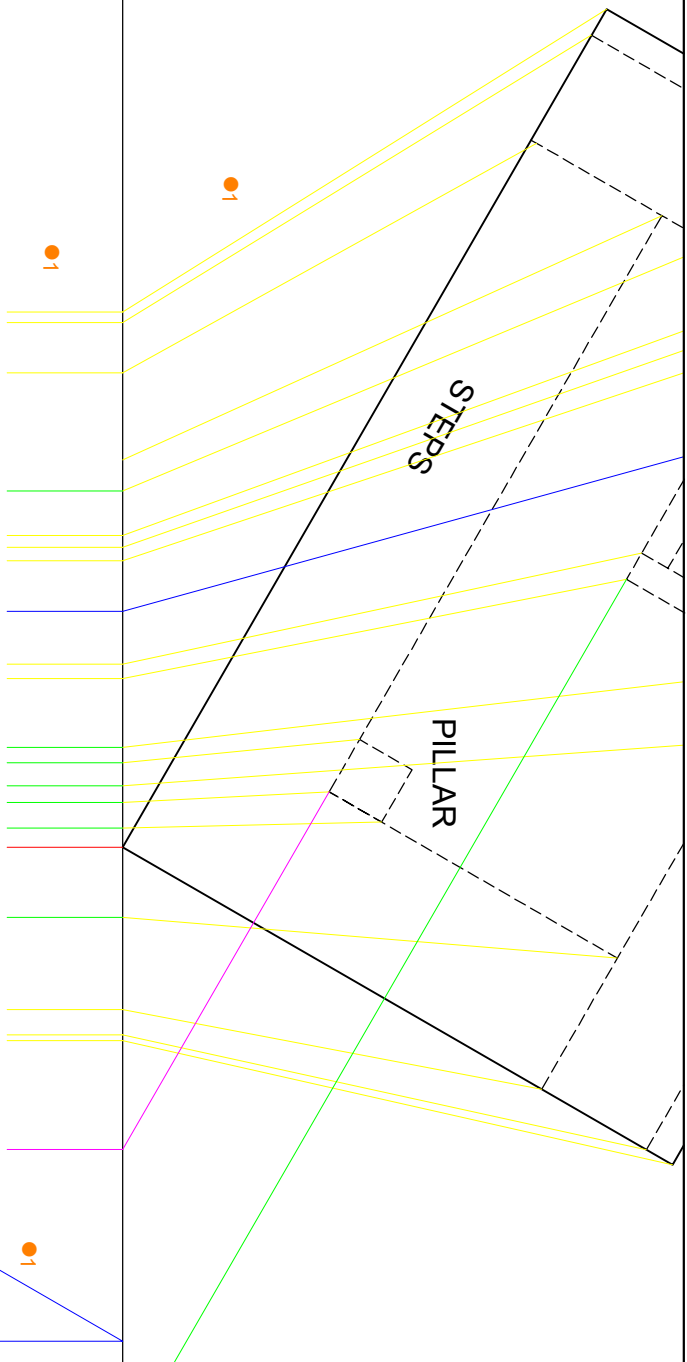

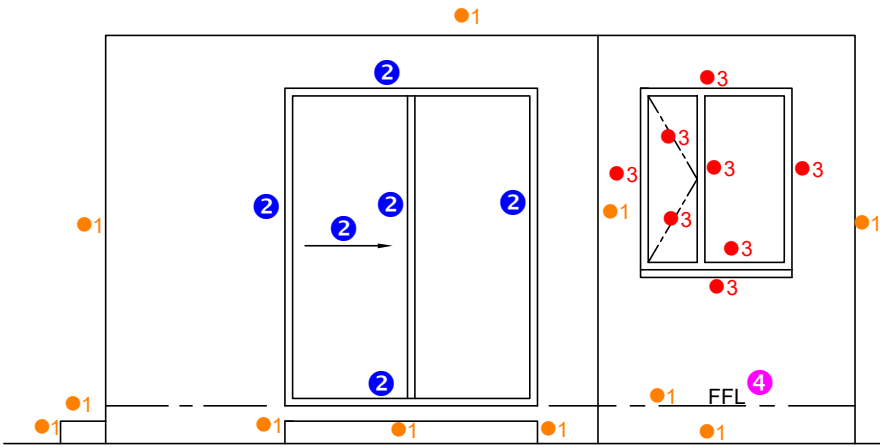

NORTH ELEVATION
SCALE 1 : 50

ASSESSMENT CRITERIA		
NORTH ELEVATION		
1	WALLS + STEPS	5 ½
2	SLIDING DOOR	3
3	WINDOW	4
4	LABELS	2
SUBTOTAL		14 ½

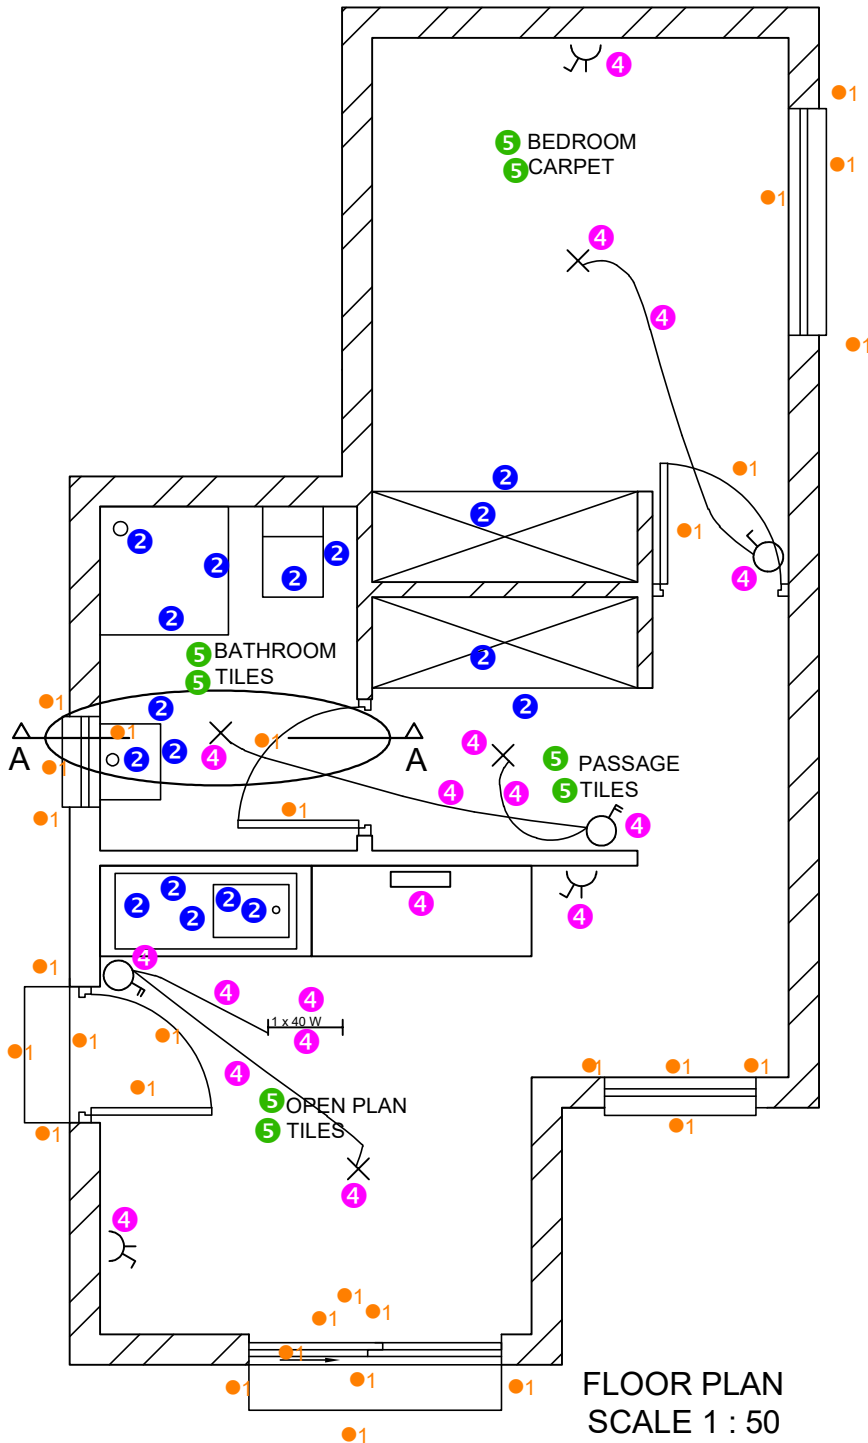

FLOOR PLAN
SCALE 1 : 50


ASSESSMENT CRITERIA		
FLOOR PLAN		
1	DOORS + WINDOWS + STEPS	15
2	FIXTURES	8 ½
3	HATCHING	4
4	ELECTRICAL	9
5	LABELS	4
SUBTOTAL		40 ½

EGD GRADE 11
NOVEMBER 2025
PAPER 1

ASSESSMENT CRITERIA

DETAILED SECTION

1	FOUNDATIONS + WALLS + SLAB + LINTELS	11	
2	DOOR + WINDOW	5	
3	HATCHING	8	
4	LABELS	2	
5	FIXTURES	4	
SUBTOTAL		30	

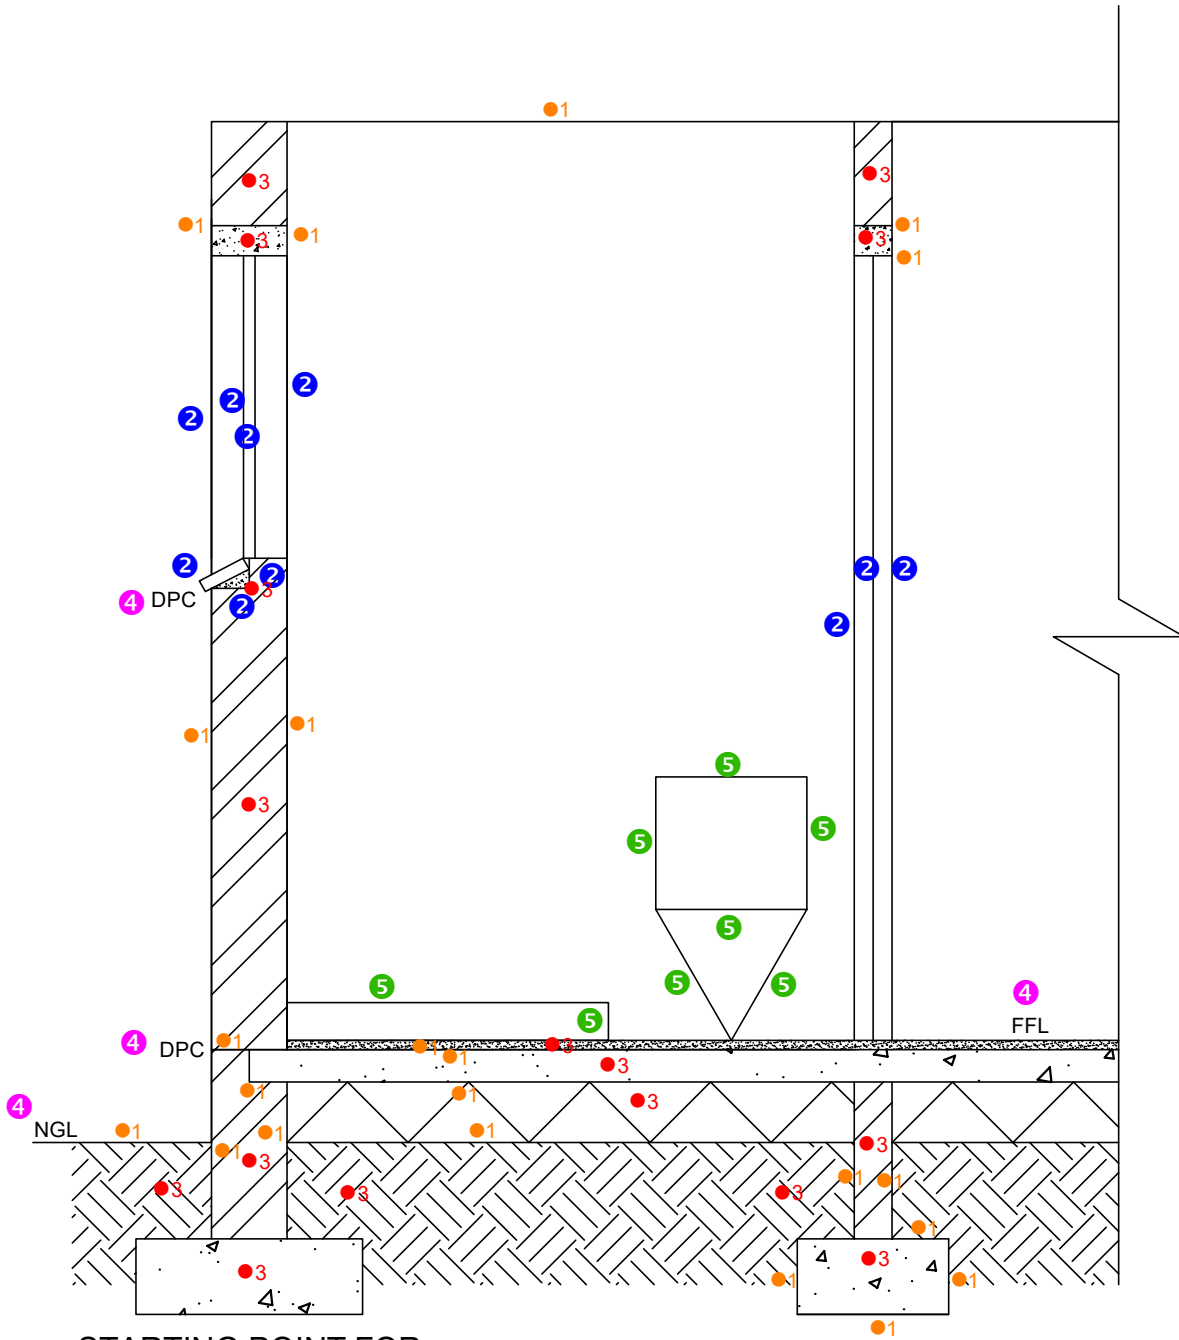

STARTING POINT FOR
 DETAILED SECTION
 (EXTERNAL WALL
 FOUNDATION)

SECTION A-A
 SCALE 1 : 20